

SECOND FLOOR PLAN

			WINDOW S	CHEDULE	
LTR.	MANUF.	QUANITY	MODEL NO.	ROUGH OPENING	REMARKS
Δ	WINDSOR	4	3226-2	6′-3 5/8" X 5′-1 1/4"	
В	WINDSOR	4	2826	2′-10 1/4" X 5′-1 1/4"	MEETS EGRESS OF 5.0 SQ. FT.
C	WINDSOR	9	2816	2′-10 1/4" X 3′-5 1/4"	
D	WINDSOR	16	3224	3′-2 1/4" X 4′-9 1/4"	MEETS EGRESS OF 5.0 SQ. FT.
£	WINDSOR	5	2416	2′-6 1/4" X 3′-5 1/4"	
F P	ER BUILDER	4	BASEMENT WINDOW	PER BUILDER	
G					
H					
ı					
]					
K					
L					
	NOTES:	MEET EGRESS OF 5.7	SO FT OF CLEAR OPN'S		
		MEET EGRESS OF 5.7	SQ. FT. OF CLEAR OPN'G	CHEDULE	
		MEET EGRESS OF 5.7			REMARKS
NO.	WINDOWS B & D /	TYPE INSUL MY'L.	DOOR SC	CHEDULE	REMARKS
NO.	QUANT'Y	TYPE INSUL AT'L. SWING INSUL AT'L.	DOOR SO	CHEDULE SIZE	REMARKS
NO.	QUANT'Y	TYPE INSUL AT'L. SWING	DOOR SO	SIZE 3'-0" X 6'-8"	REMARKS
NO. 1 2	QUANT Y	TYPE INSUL MTL SWING INSUL MTL SWING	DOOR SO	SIZE 3'-0" X 6'-8" 2'-8" X 6'-8"	REMARKS
NO. 1 2 3	QUANT'Y 16 4 28	TYPE INSUL AI'L. SWING INSUL AI'L. SWING W'D SWING	DOOR SC FRAME WOOD WOOD	SIZE 3'-0" X 6'-8" 2'-8" X 6'-8" 2'-6" X 6'-8"	REMARKS
NO. 1 2 3 4	QUANT'Y 16 4 28 4	TYPE INSUL. AT'L. SWING INSUL. AT'L. SWING W'D SWING W'D SWING	DOOR SO	SIZE 3'-0" X 6'-8" 2'-8" X 6'-8" 2'-6" X 6'-8" 2'-4" X 6'-8"	REMARKS
No. 1 2 3 4 5	QUANT'Y 16 4 28 4	TYPE INSUL M7'L SWING INSUL M7'L SWING W'D SWING W'D SWING W'D SWING	DOOR SO	SIZE 3'-0" X 6'-8" 2'-8" X 6'-8" 2'-6" X 6'-8" 2'-4" X 6'-8" 2'-0" X 6'-8"	REMARKS
NO. 1 2 3 4 5	QUANT'Y 16 4 28 4 4	TYPE INSUL MITL SWING INSUL MITL SWING W'D SWING W'D SWING W'D SWING W'D SWING W'D P'KT.	DOOR SC FRAME WOOD WOOD WOOD WOOD WOOD	SIZE 3'-0" X 6'-8" 2'-8" X 6'-8" 2'-6" X 6'-8" 2'-4" X 6'-8" 2'-0" X 6'-8" 2'-0" X 6'-8"	REMARKS
NO. 1 2 3 4 5 6 7	QUANT'Y 16 4 28 4 4 12	TYPE INSUL AIT'L. SWING INSUL AIT'L. SWING W'D SWING W'D SWING W'D SWING W'D P'KT. W'D B'FLD.	FRAME WOOD WOOD WOOD WOOD WOOD WOOD WOOD	SIZE 3'-0" X 6'-8" 2'-8" X 6'-8" 2'-6" X 6'-8" 2'-4" X 6'-8" 2'-0" X 6'-8" 2'-6" X 6'-8" 5'-0" X 6'-8"	REMARKS

To the best of my knowledge these plans are drawn to comply with owner's and/ or builder's specifications and must be verified by a qualified structural engineer before construction begins. Any changes made on them after prints are made will be done at the owner's and / or builder's expense and responsibility. The contractor shall verify all dimensions and enclosed drawing. RESIDENTIAL DESIGN SERVICES, INC. is not liable for errors once construction has begun. While every effort has been made in the preparation of this plan to avoid mistakes, the maker can not guarantee against human error. The contractor of the job must check all dimensions and other details prior to construction and be solely responsible thereafter.

- NOTES:

 1) BUILDING CONTRACTOR/HOME OWNER TO REVIEW AND VERIFY ALL DIMENSIONS, SPECS, AND CONNECTIONS BEFORE CONSTRUCTION BIGINS
- CONNECTIONS BEFORE CONSTRUCTION BIGINS

 2) ALL JOIST, RAFTER, AND BEAM SIZES AND DESIGN MUST BE VERIFIED FOR COMPLIANCE WITH LOCAL CODES AND BUILDING CONDITIONS, PRIOR TO BEGINNING CONSTRUCTION.

 3) VERIFY WINDOW SIZES WITH WINDOW MANUFACTURER FOR COMPLIANCE WITH INGRESS/EGRESS REQUIREMENTS.
- 4) ATTIC VENITLATION SHALL BE DESIGNED ACCORDING TO LOCAL CODES AND CLIMATE.
 5) PROVIDE PROPER FLASHING WHERE REQUIRED.
 6) THE DESIGN OF ALL STAIRCASES MUST COMPLY WITH THE LATES CODES AND REQUIREMENTS
 7) BATHROOM WINDOWS 60" ABOVE TUBS AND SHOWERS TO BE TEMPERED GLASS

I/ WE HAVE REVIEWED THIS CONSTRUCTION BLUEPRINT AND UNDERSTAND TOTALLY, THE
WORK TO BE PERFORMED, ANY ERRORS, OMMISSIONS, OR DISCUSSIONS NOT
SPECIFICALLY LISTED ON THE BLUEPRINT, OR WRITTEN INTO THE CUSTOM
SPECIFICATIONS HAVE NOT BEEN CHARGED FOR BY THE BUILDER, AND
THEREFORE BECOME EXTRAS BEYOND THE CONTRACT TO BE PAID FOR BY US,

DRAWN BY

RDS, INC.
AUTHORIZATION NO.

NAME

DATE:

NEW RESIDENCE FOR:

ARCHBALD TOWNHOUSES

4-UNIT

SCALE: 1/4"=1'

DRAWN BY
RDS, INC.
AUTHORIZATION NO.

DATE:

W/ D SCHEDULE

REVISIONS

REVISIONS

REVISIONS

REVISIONS


REVISIONS


REVISIONS

PAGE


REVISIONS

A-5

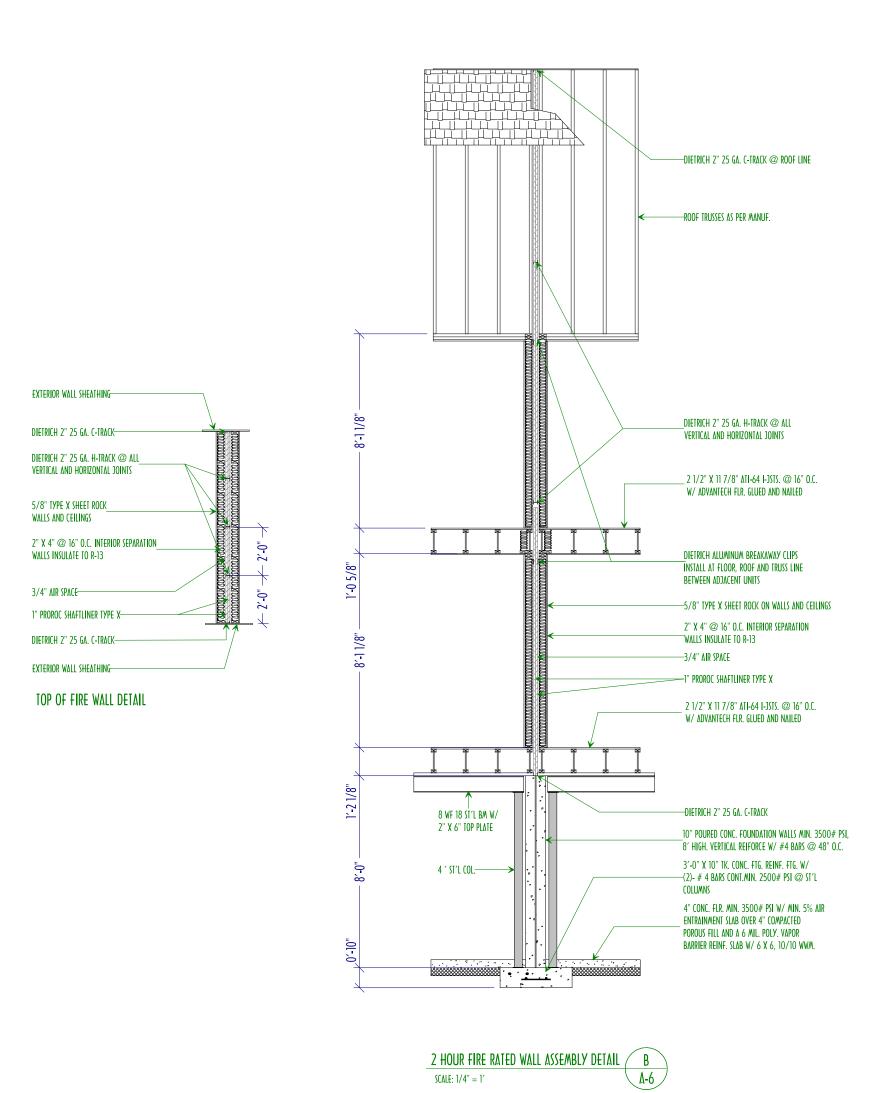

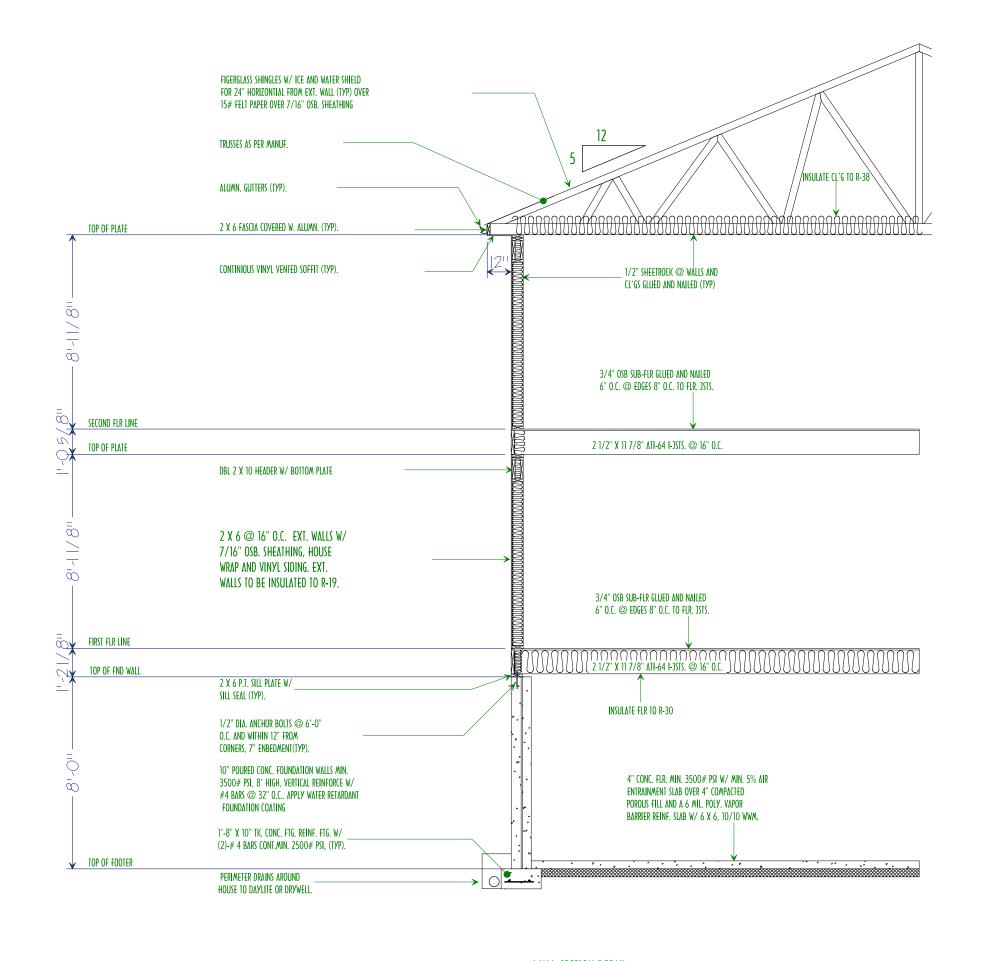

WALL SECTION DETAIL

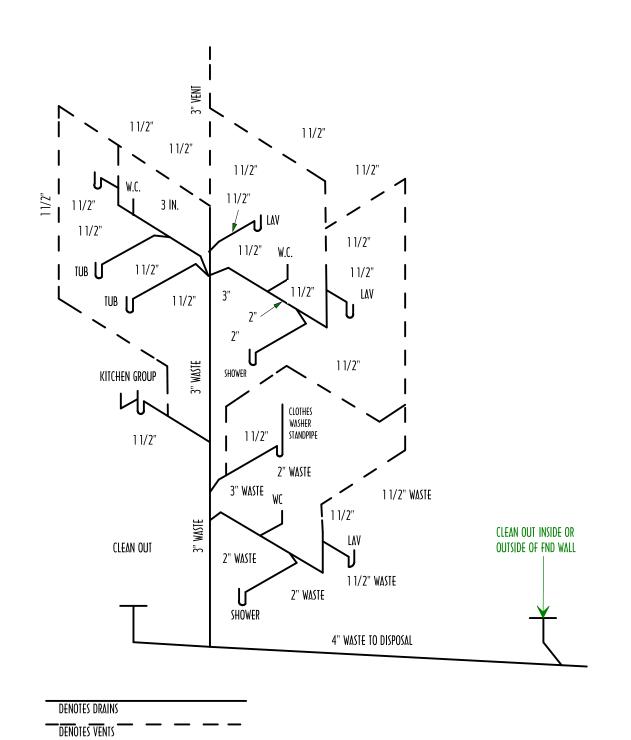

PLUMBING RISER INFORMATION MAY CHANGE DUE TO SITE CONDITIONS.

4) ATTIC VENTILATION SHALL BE DESIGNED ACCORDING TO LOCAL CODES AND CLIMATE.
5) PROVIDE PROPER FLASHING WHERE REQUIRED.

7) BATHROOM WINDOWS 60" ABOVE TUBS AND SHOWERS TO BE TEMPERED GLASS

PLUMBING RISER DIAGRAM


N.T.S.

To the best of my knowledge these plans are drawn to comply with owner's and/ or builder's specifications and must be verified by a qualified structural engineer before construction begins. Any changes made on them after prints are made will be done at the owner's and/ or builder's expense and responsibility. The contractor shall verify all dimensions and enclosed drawing. RESIDENTIAL DESIGN SERVICES, INC. is not liable for errors once construction has begun. While every effort has been made in the preparation of this plan to avoid mistakes, the maker can not guarantee against human error.

The contractor of the job must check all dimensions and other details prior to construction and be solely responsible thereafter.

6) THE DESIGN OF ALL STAIRCASES MUST COMPLY WITH THE LATES CODES AND REQUIREMENTS DATE:

NEW RESIDENCE FOR: ARCHBALD TOWNHOUSES SCALE: 1/4"=1' DRAWING CHECKED BY SECTION DETAILS - DESIGN CRITERIA -RDS, INC. PLAN NOTES - PLUMBING RISER DIAGRAM

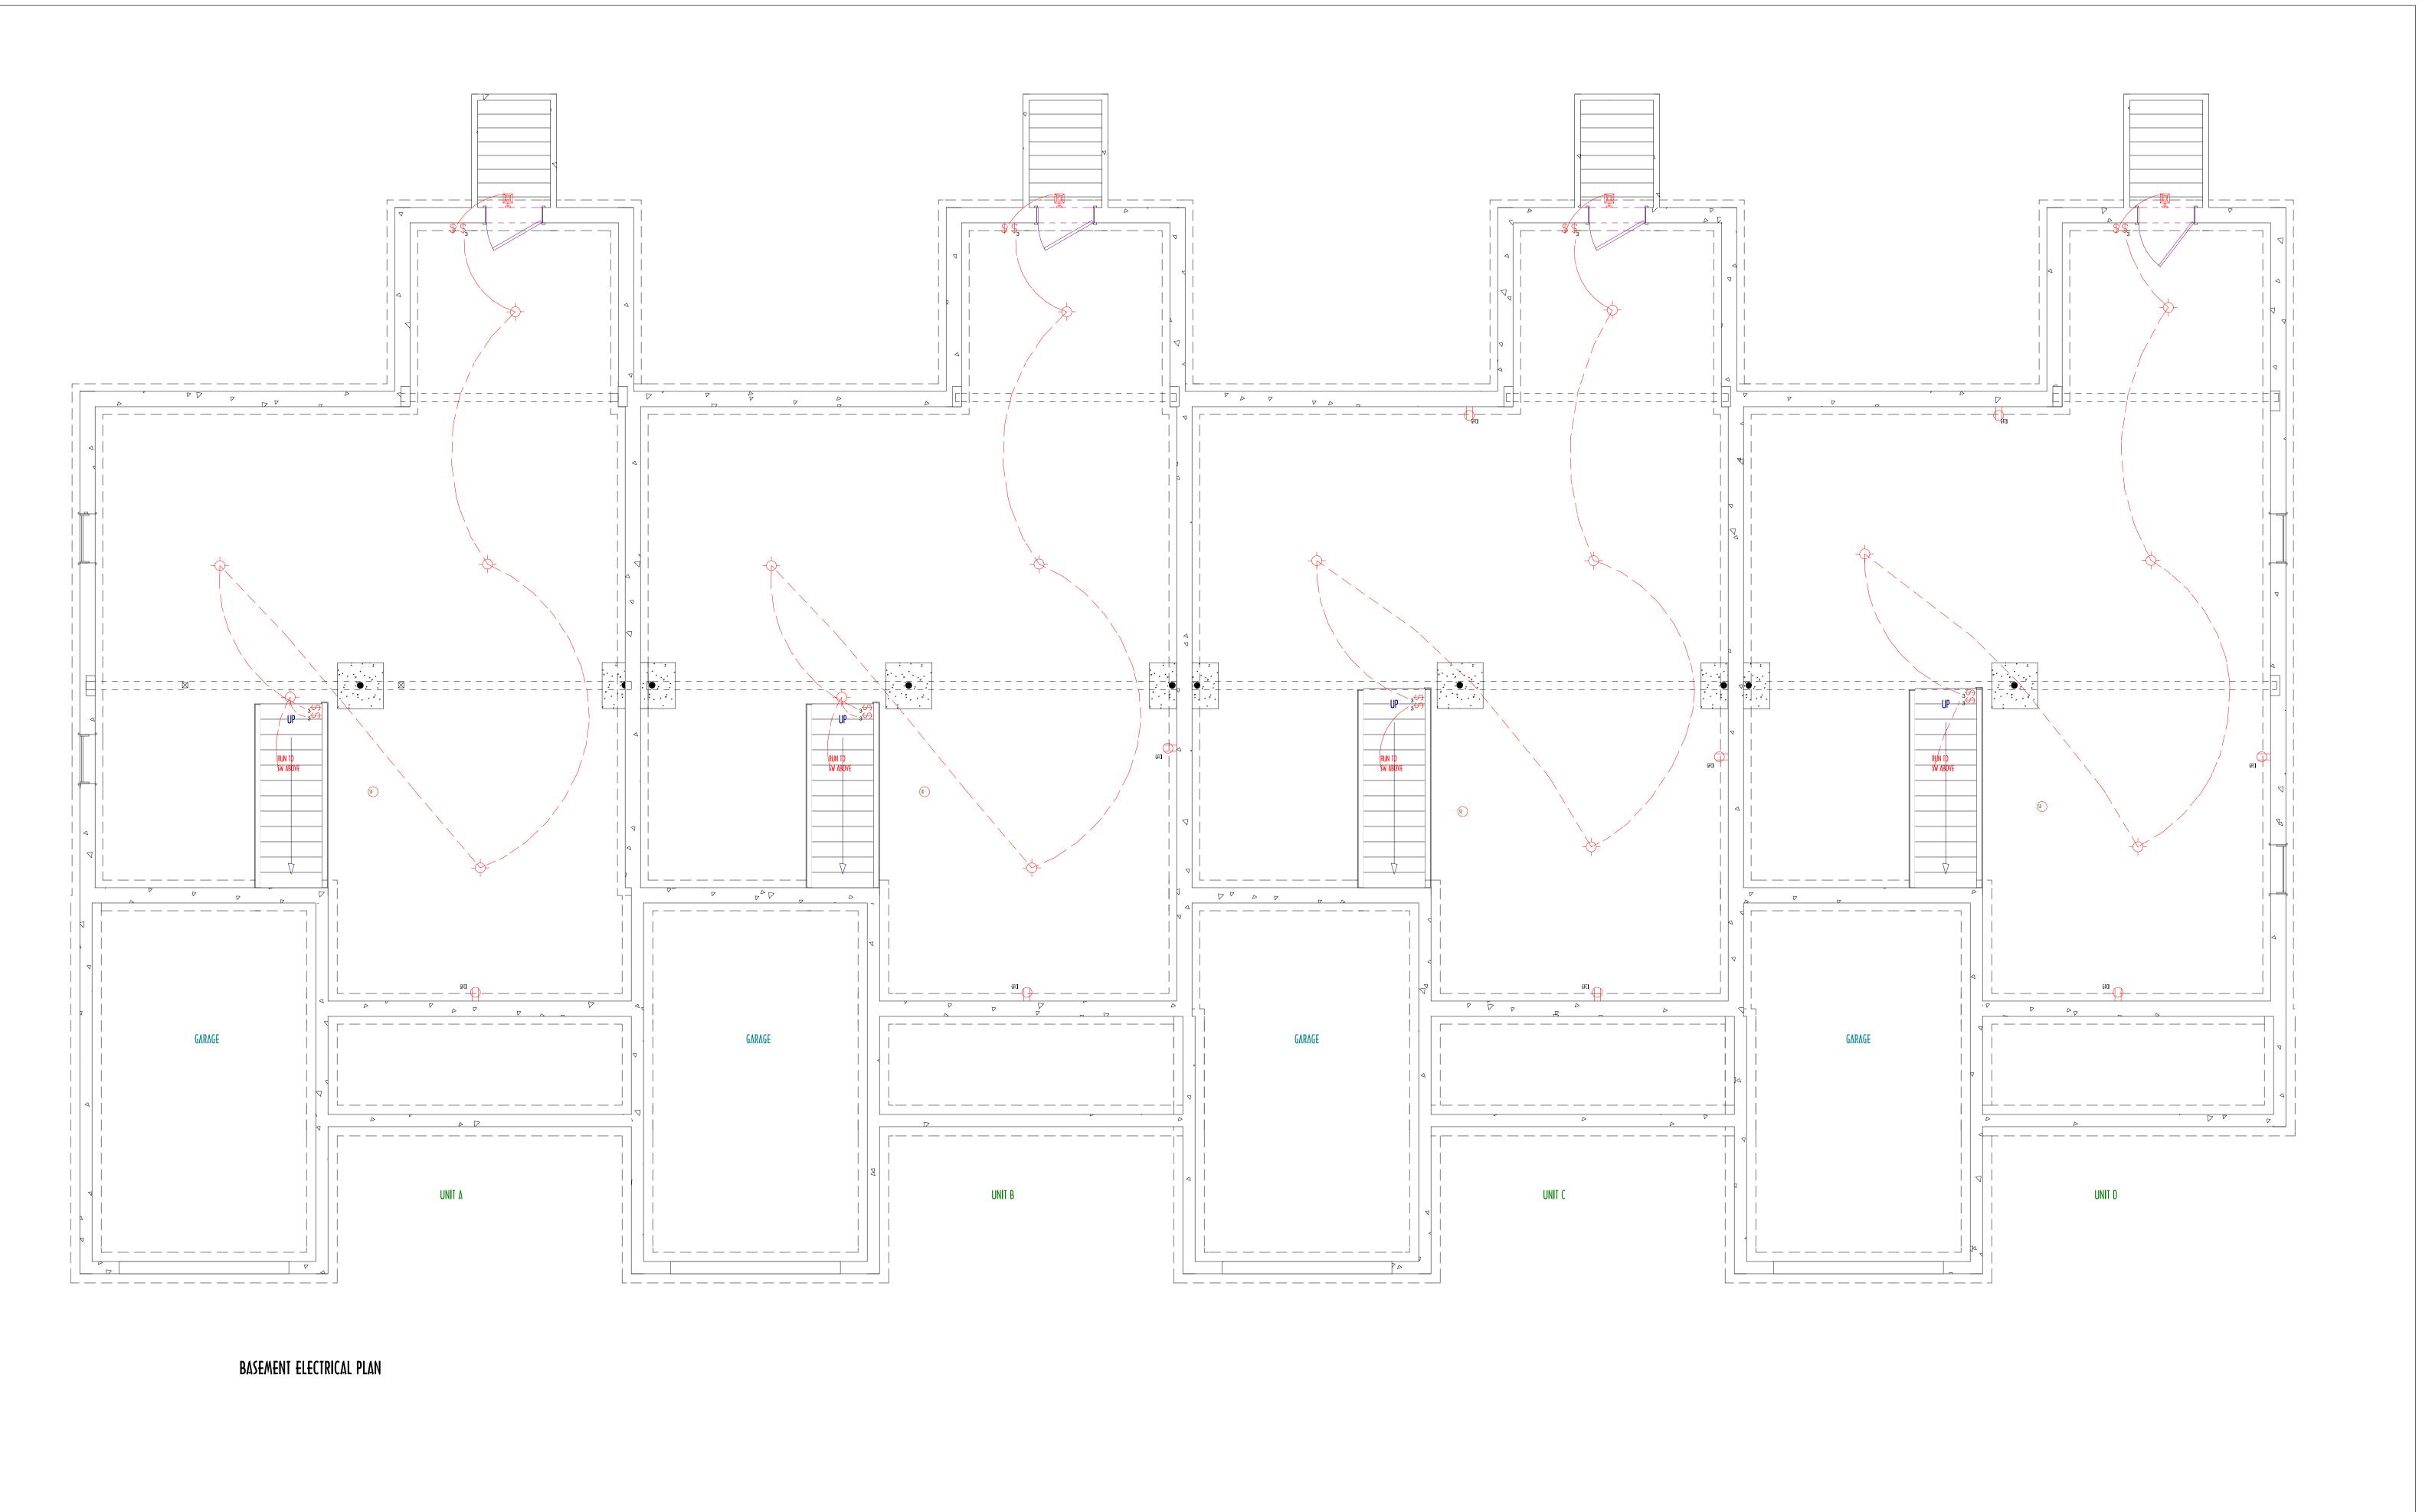

To the best of my knowledge these plans are drawn to comply with owner's and/ or builder's specifications and must be verified by a qualified structural engineer before construction begins. Any changes made on them after prints are made will be done at the owner's and / or builder's expense and responsibility. The contractor shall verify all dimensions and enclosed drawing. RESIDENTIAL DESIGN SERVICES, INC. is not liable for errors once construction has begun. While every effort has been made in the preparation of this plan to avoid mistakes, the maker can not guarantee against human error. The contractor of the job must check all dimensions and other details prior to construction and be

NC	TES:
D	BUILDING CONTRACTOR/HOME OWNER TO REVIEW AND VERIFY ALL DIMENSIONS, SPECS, AND
	CONNECTIONS BEFORE CONSTRUCTION BIGINS
0	ALL LOICE MARKIN AND BRAIL CITE AND BROLON AND REPORT OF A PRIPIED FOR COMPUNITE WHAT

ALL JOIST, RAFTER, AND BEAM SIZES AND DESIGN MUST BE VERIFIED FOR COMPLIANCE WITH LOCAL CODES AND BUILDING CONDITIONS, PRIOR TO BEGINNING CONSTRUCTION.
 VERIFY WINDOW SIZES WITH WINDOW MANUFACTURER FOR COMPLIANCE WITH INGRESS/EGRESS REQUIREMENTS.
 ATTIC VENTILATION SHALL BE DESIGNED ACCORDING TO LOCAL CODES AND CLIMATE.
 PROVIDE PROPER FLASHING WHERE REQUIRED.

) ATTIC VENTILATION SHALL BE DESIGNED ACCORDING TO LOCAL CODES AND CLIMATE.	
) PROVIDE PROPER FLASHING WHERE REQUIRED.	
) THE DESIGN OF ALL STAIRCASES MUST COMPLY WITH THE LATES CODES AND REQUIREMENTS	
) BATHROOM WINDOWS 60" ABOVE TUBS AND SHOWERS TO BE TEMPERED GLASS	

I/ WE HAVE REVIEWED THIS CONSTRUCTION BLUEPRINT AND UNDERSTAND TOTALLY, THE WORK TO BE PERFORMED, ANY ERRORS, OMMISSIONS, OR DISCUSSIONS NOT SPECIFICCALLY LISTED ON THE BLUEPRINT, OR WRITTEN INTO THE CUSTOM SPECIFICATIONS HAVE NOT BEEN CHARGED FOR BY THE BUILDER, AND THEREFORE BECOME EXTRAS BEYOND THE CONTRACT TO BE PAID FOR BY US,		Di
NAME	DATE:	RDS,
NA/NE	DATE:	

NEW RESIDENCE FOR:

ARCHBALD TOWNHOUSES

4-UNIT

DRAWN BY
RDS, INC.

AUTHORIZATION NO.

DATE:

10 (2) (1001)

REVISIONS

REVISIONS

REVISIONS


REVISIONS


PARCHBALD TOWNHOUSES

SCALE: 1/4"=1'

DRAWING

E-1

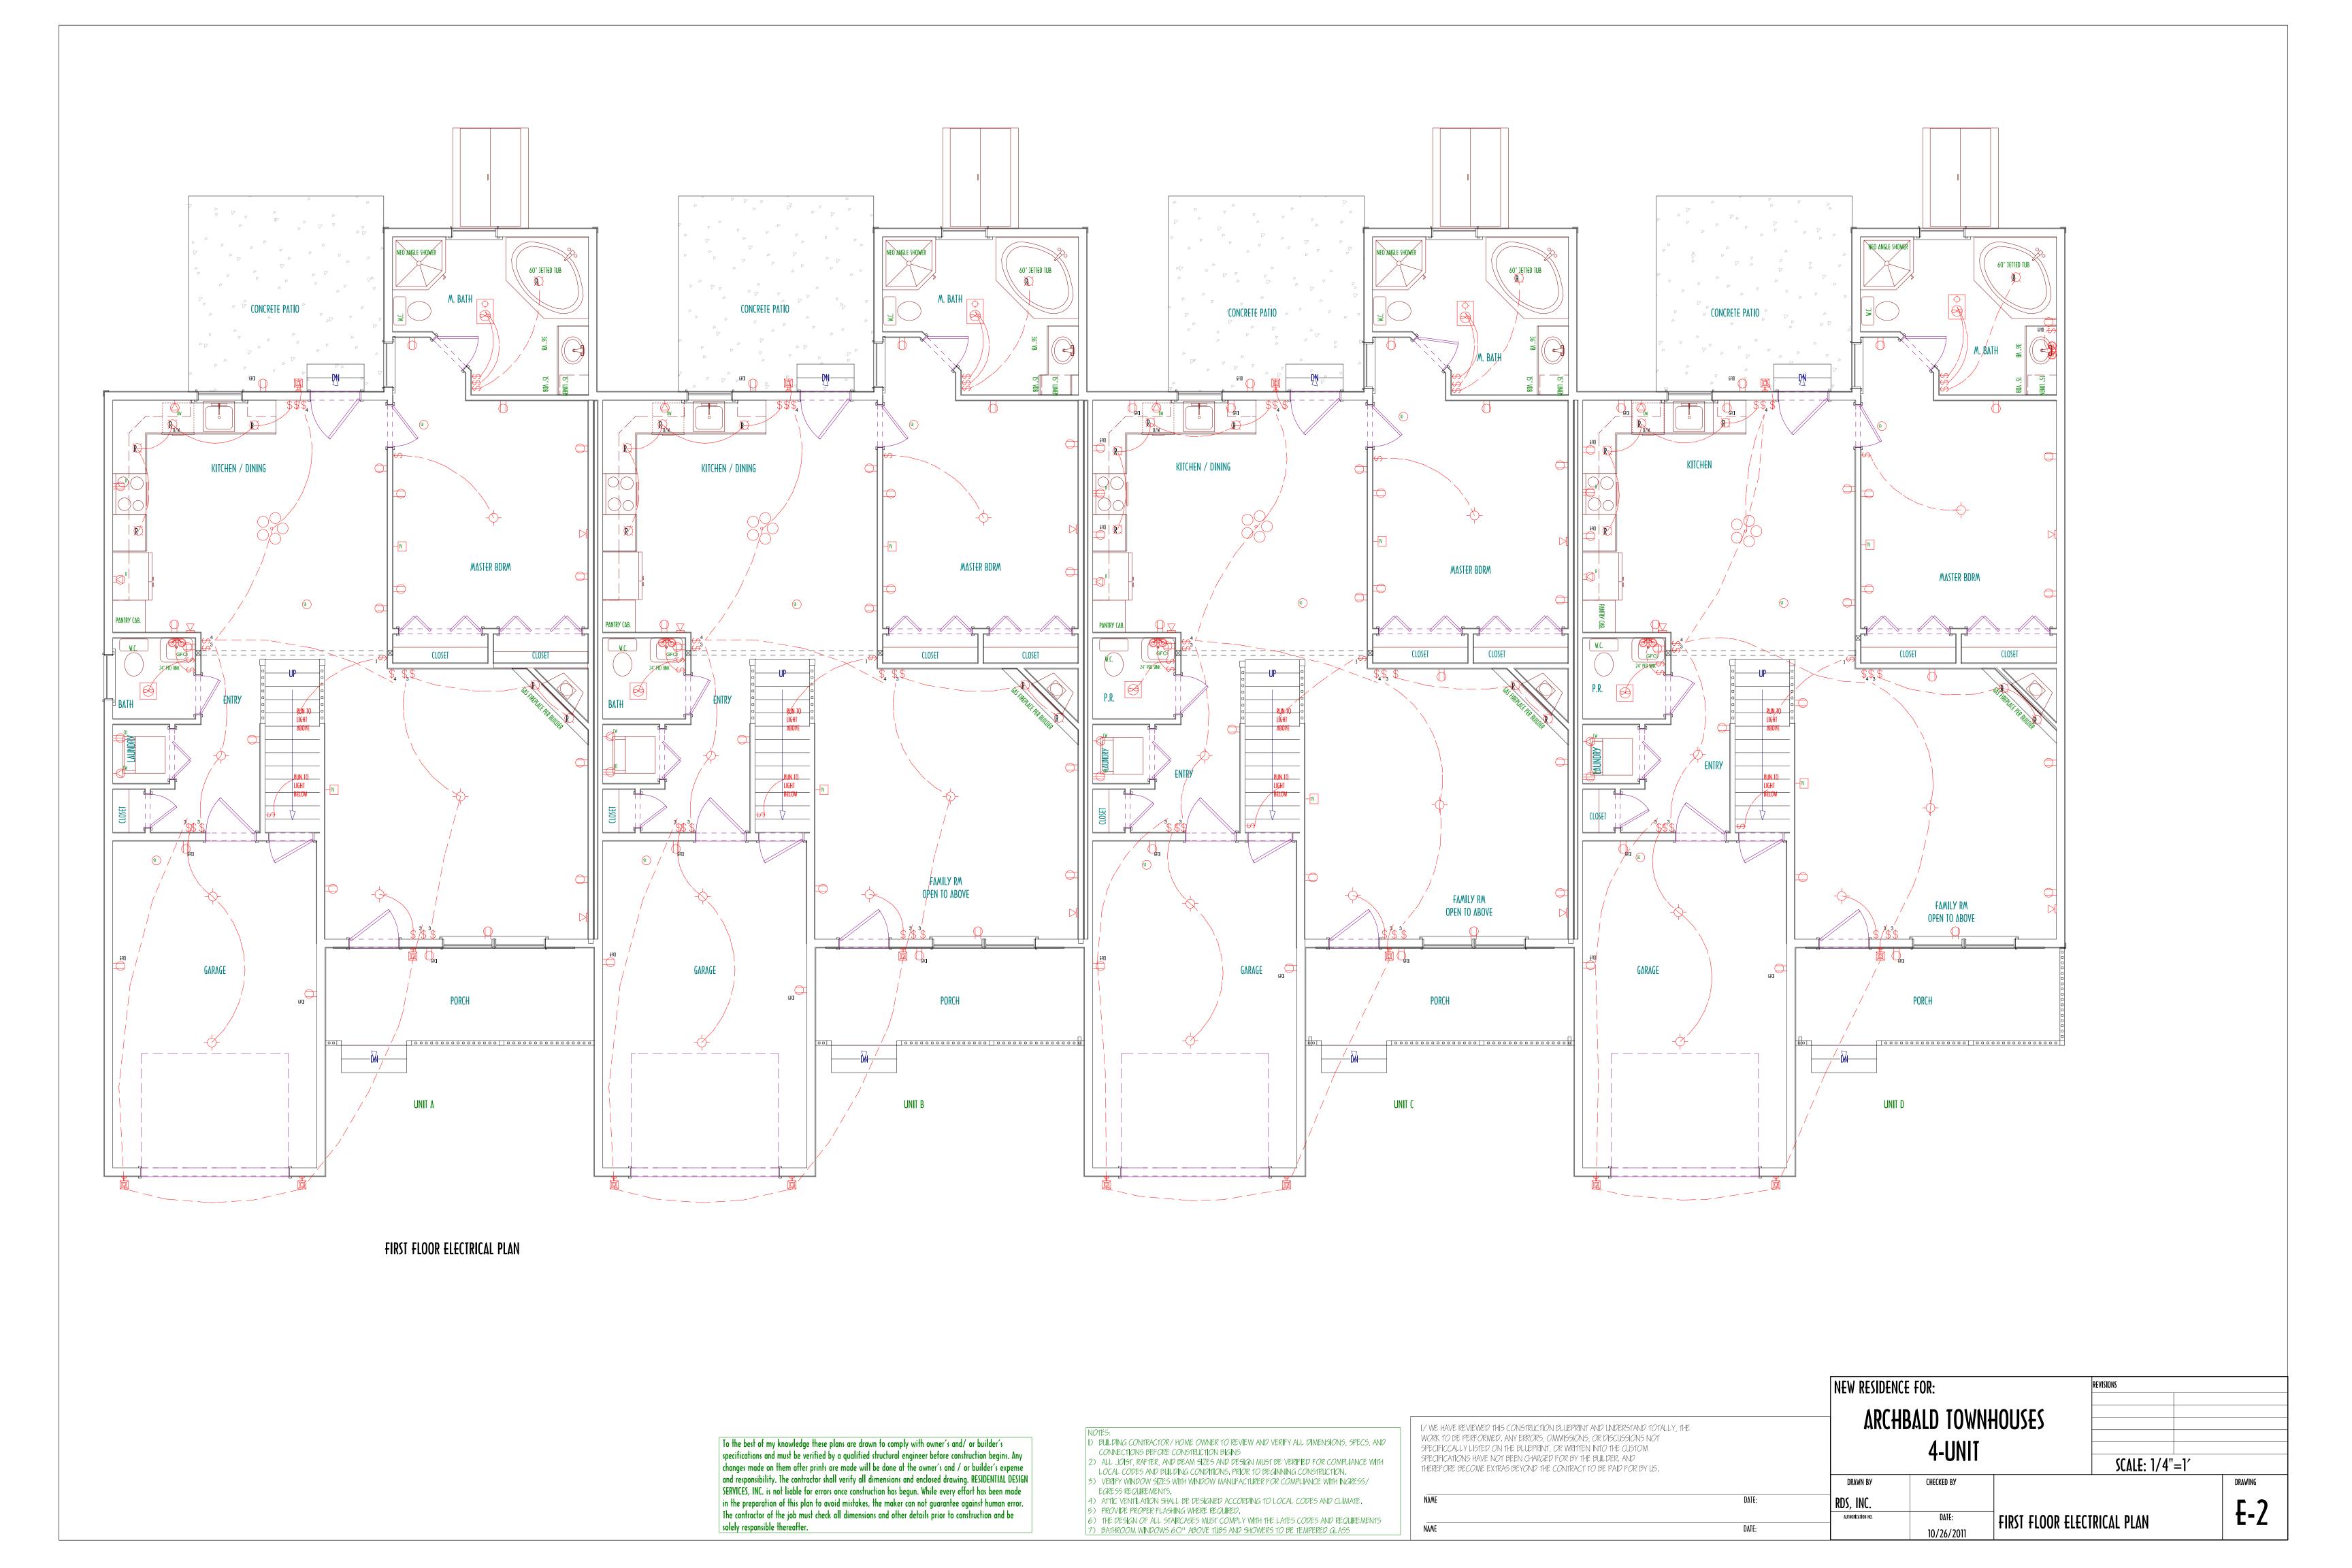

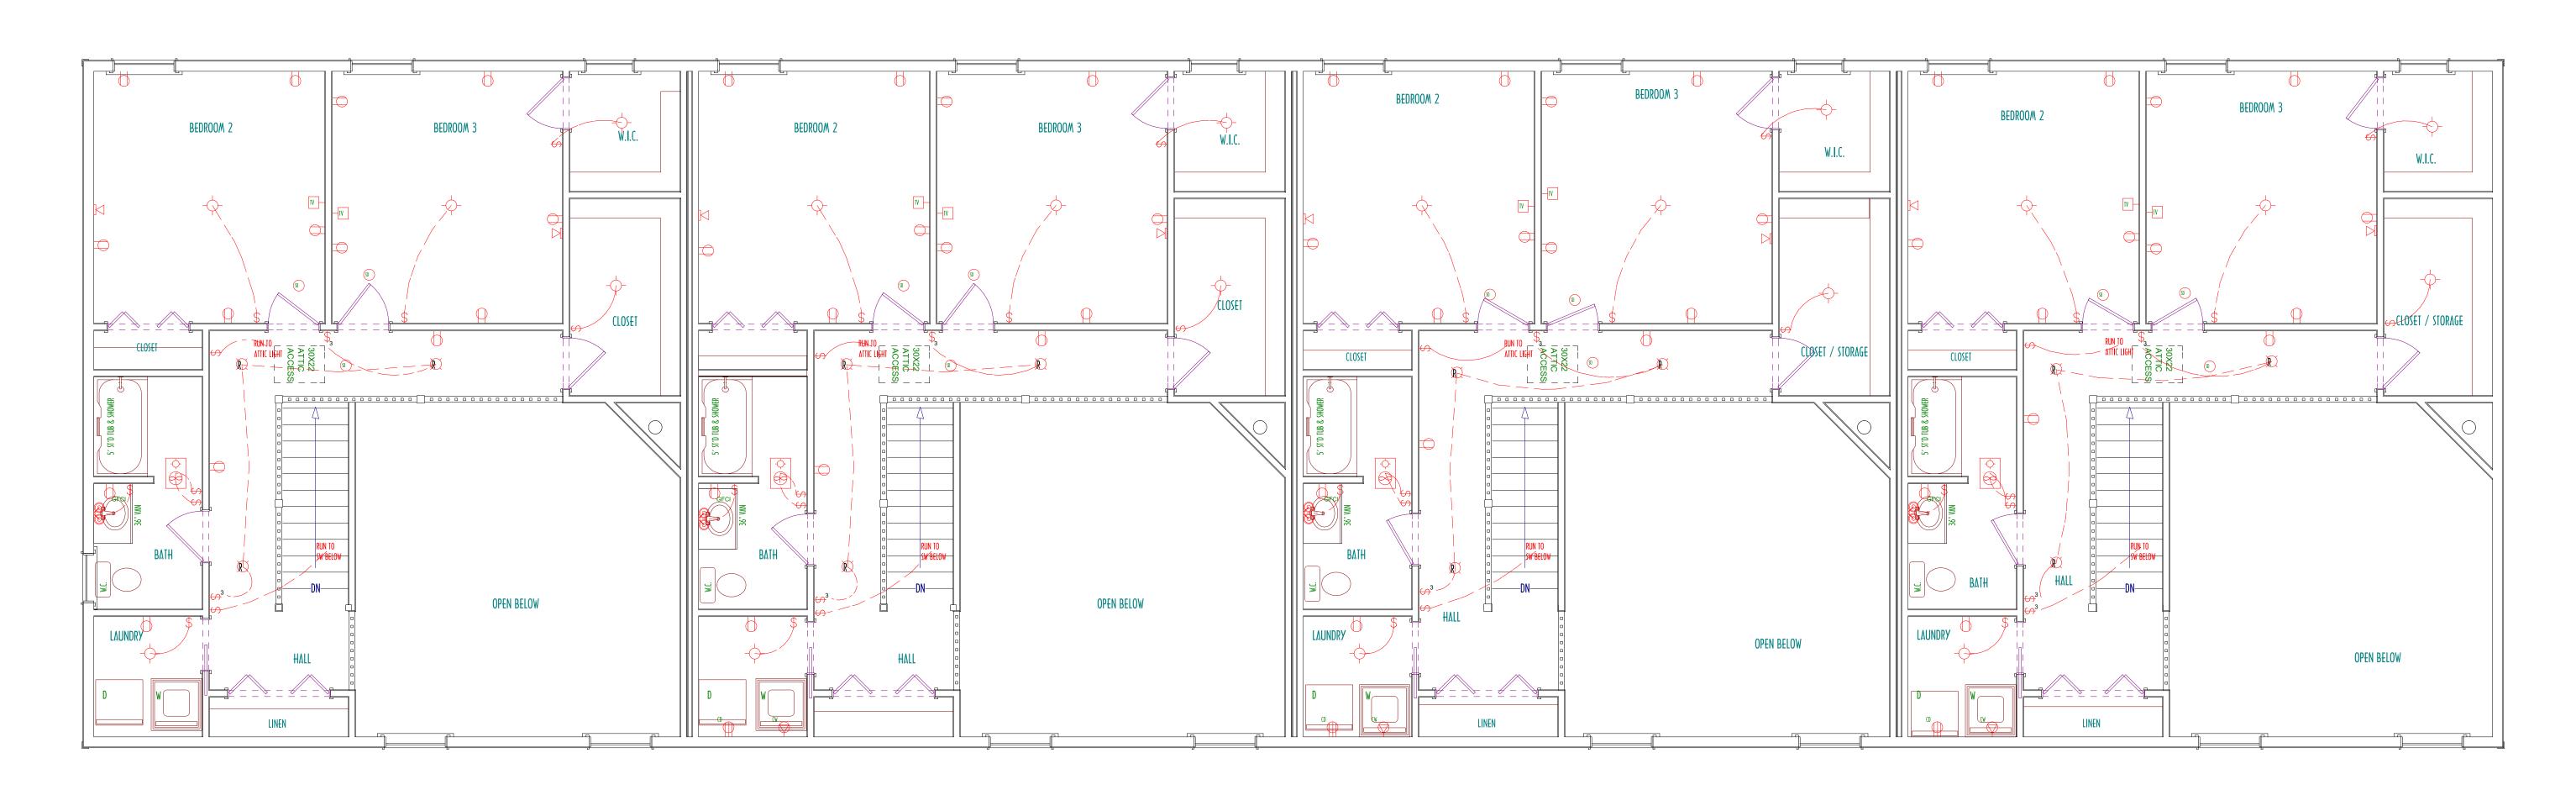

SECOND FLOOR ELECTRICAL PLAN

UNIT A UNIT B UNIT C UNIT D

To the best of my knowledge these plans are drawn to comply with owner's and/ or builder's specifications and must be verified by a qualified structural engineer before construction begins. Any changes made on them after prints are made will be done at the owner's and / or builder's expense and responsibility. The contractor shall verify all dimensions and enclosed drawing. RESIDENTIAL DESIGN SERVICES, INC. is not liable for errors once construction has begun. While every effort has been made in the preparation of this plan to avoid mistakes, the maker can not guarantee against human error. The contractor of the job must check all dimensions and other details prior to construction and be solely responsible thereafter.

NOTES:
1) BUILDING CONTRACTOR/HOME OWNER TO REVIEW AND VERIFY ALL DIMENSIONS, SPECS, AND
CONNECTIONS BEFORE CONSTRUCTION BIGINS
a) ALL LOICE BAFRE AND PEAN CITE AND PECIAL MICE PENERRY FOR COMPLANCE WIRL

CONNECTIONS BEFORE CONSTRUCTION BIGINS

2) ALL JOIST, RAFTER, AND BEAM SIZES AND DESIGN MUST BE VERIFIED FOR COMPLIANCE WITH LOCAL CODES AND BUILDING CONDITIONS, PRIOR TO BEGINNING CONSTRUCTION.

3) VERIFY WINDOW SIZES WITH WINDOW MANUFACTURER FOR COMPLIANCE WITH INGRESS/EGRESS REQUIREMENTS.

4) ATTIC VENTILATION SHALL BE DESIGNED ACCORDING TO LOCAL CODES AND CLIMATE.

5) PROVIDE PROPER FLASHING WHERE REQUIRED.


6) THE DESIGN OF ALL STAIRCASES MUST COMPLY WITH THE LATES CODES AND REQUIREMENTS


7) BATHROOM WINDOWS 60" ABOVE TUBS AND SHOWERS TO BE TEMPERED GLASS


/ WE HAVE REVIEWED THIS CONSTRUCTION BLUEPRINT AND UNDERSTAND TOTALLY, THE VORK TO BE PERFORMED. ANY ERRORS, OMMISSIONS, OR DISCUSSIONS NOT PRECIFICALLY LISTED ON THE BLUEPRINT, OR WRITTEN INTO THE CUSTOM	
PECIFICATIONS HAVE NOT BEEN CHARGED FOR BY THE BUILDER, AND HEREFORE BECOME EXTRAS BEYOND THE CONTRACT TO BE PAID FOR BY US.	
NAME	DATE:

NEW RESIDENCE FOR: ARCHBALD TOWNHOUSES 4-UNIT SCALE: 1/4"=1' DRAWING DRAWN BY RDS, INC. SECOND FLOOR ELECTRICAL PLAN 10/26/2011



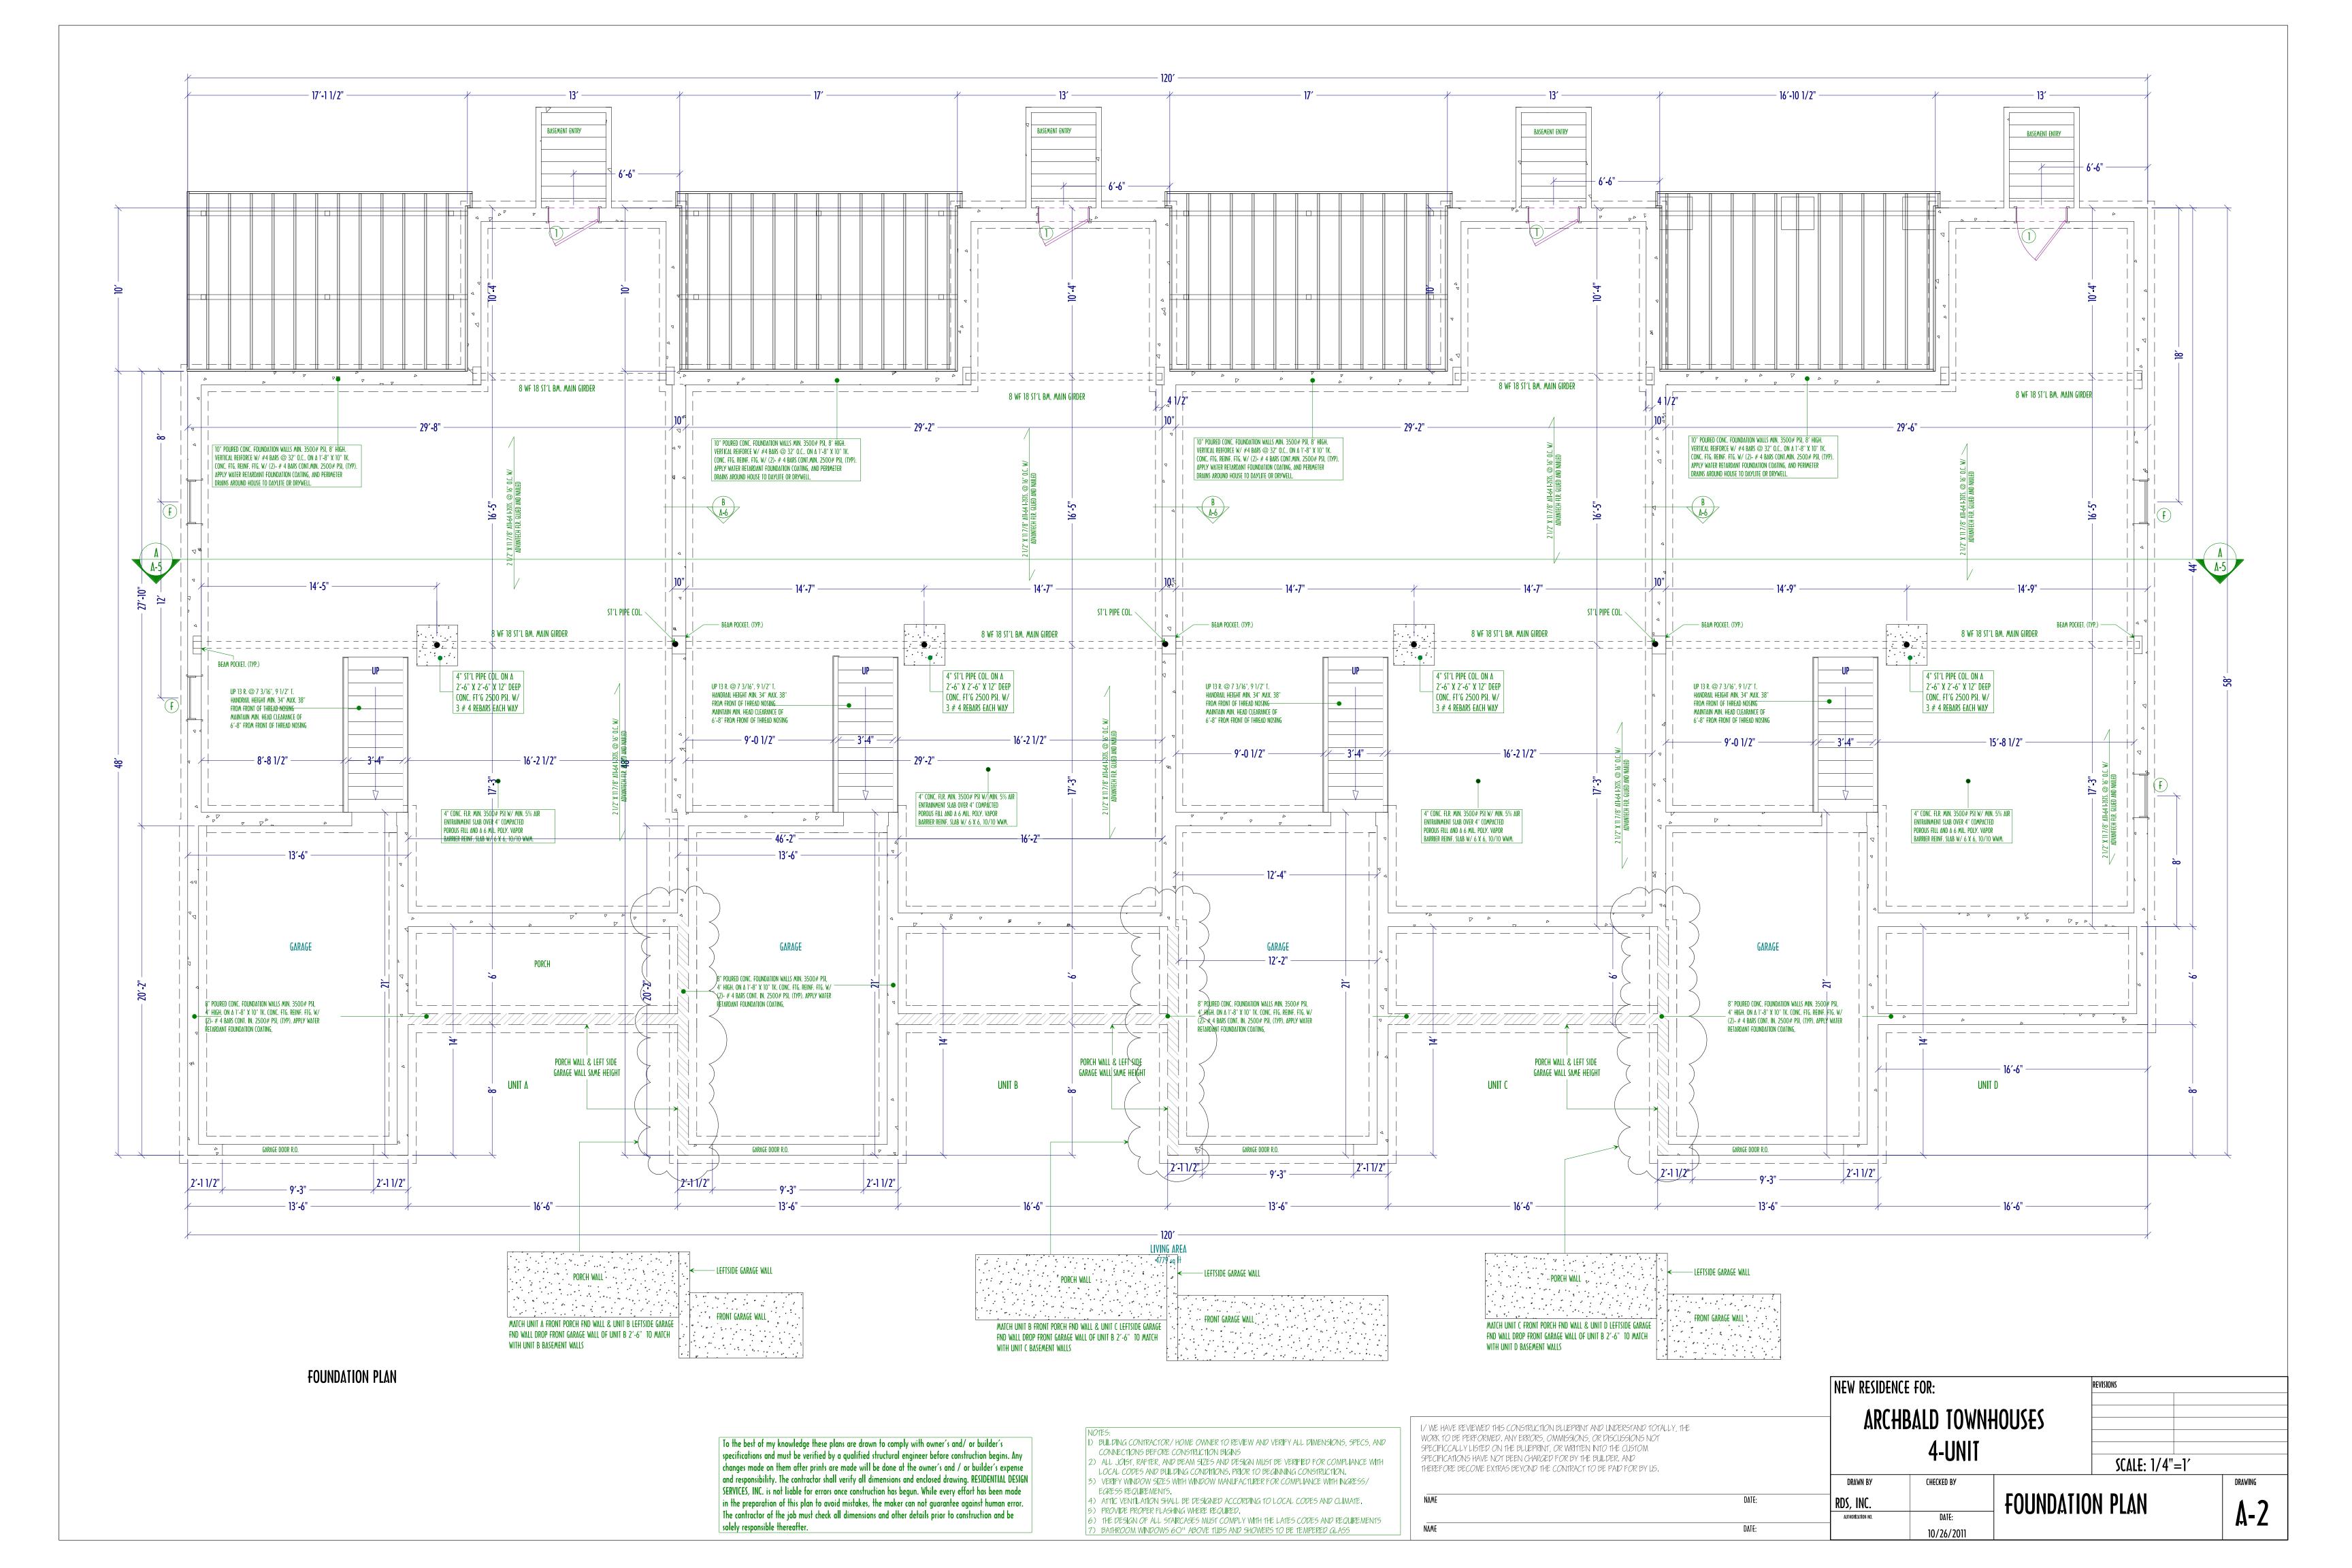

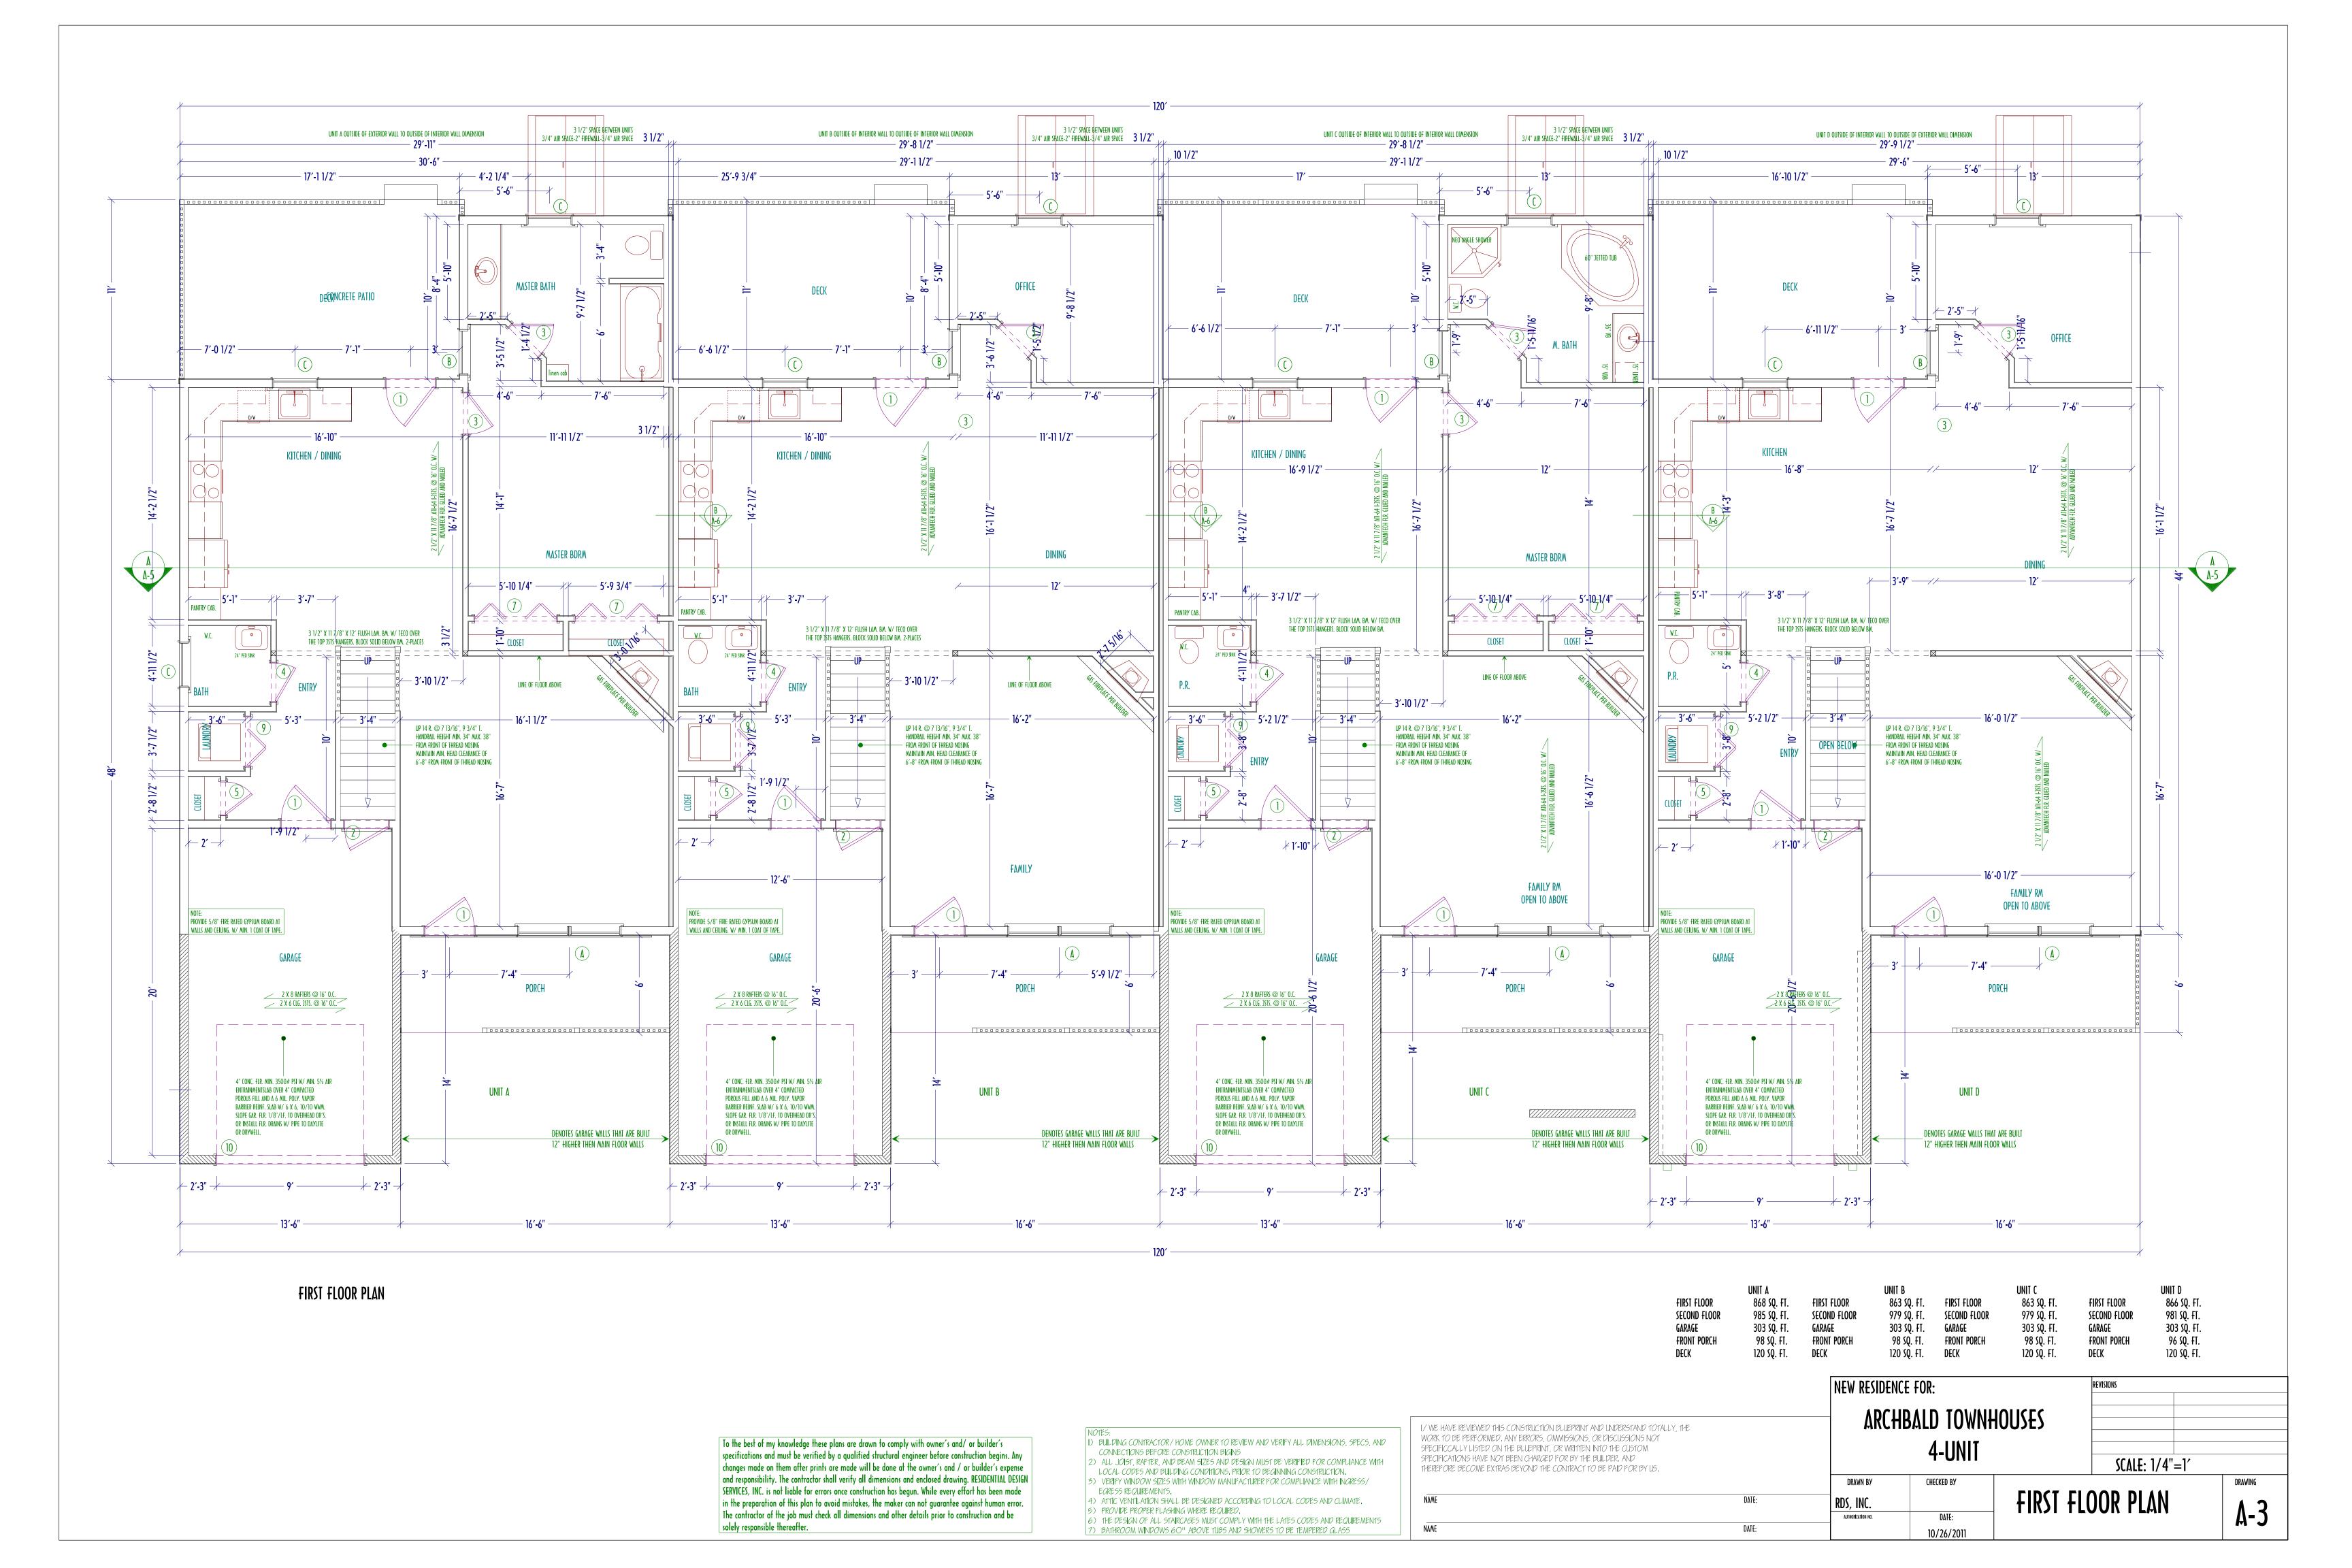

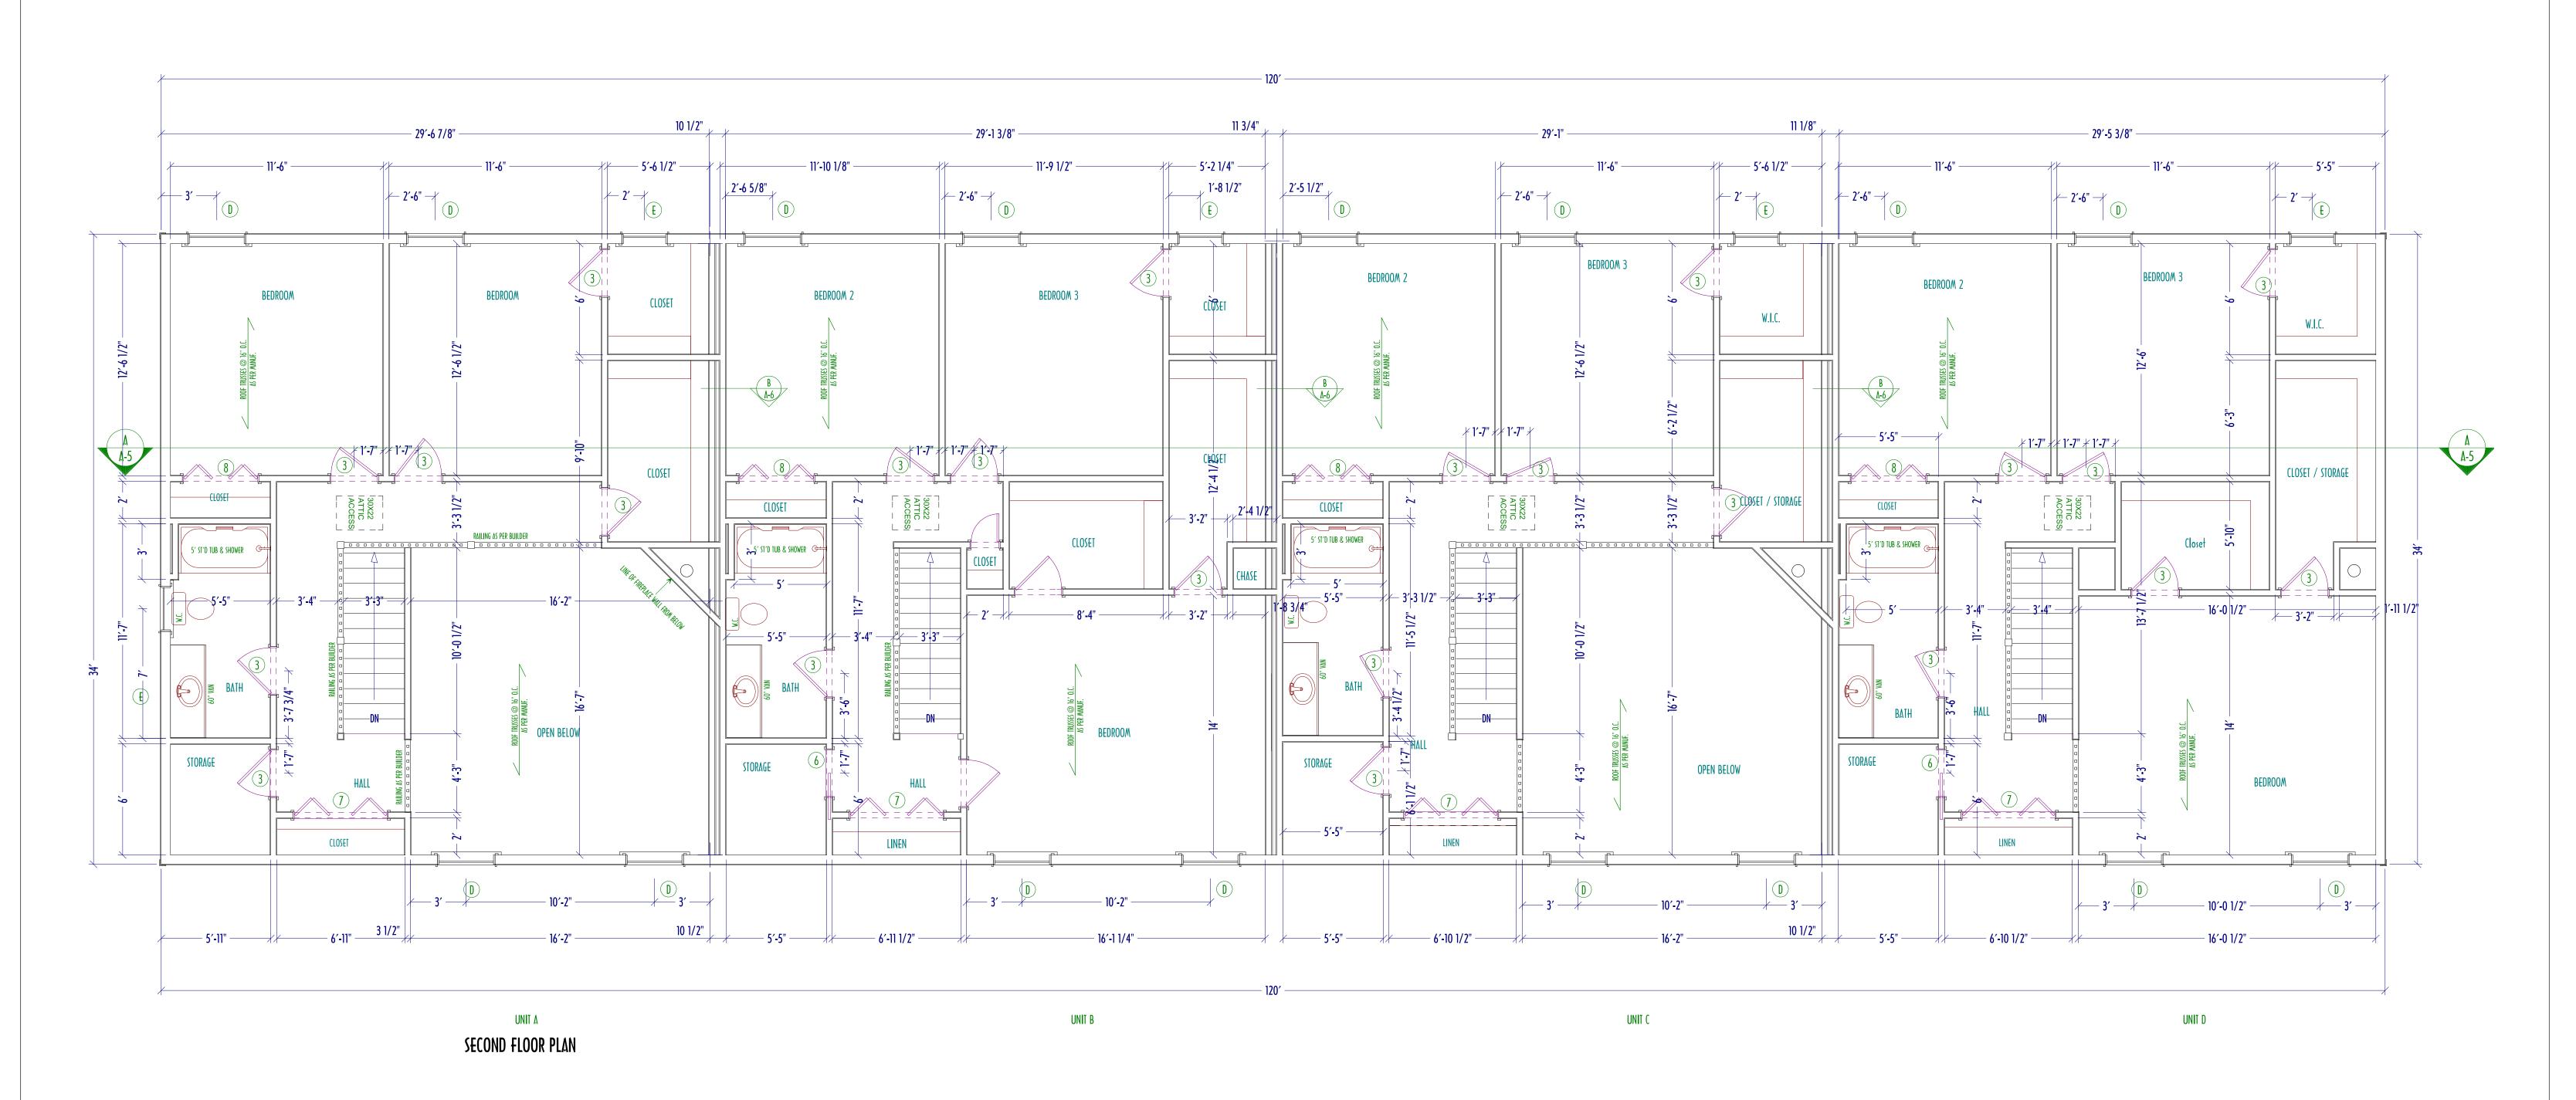

			WINDOW !	SCHEDULE	
LTR.	MANUF.	QUANITY	MODEL NO.	ROUGH OPENING	REMARKS
Δ	WINDSOR	4	3226-2	6′-3 5/8" X 5′-1 1/4"	
3	WINDSOR	4	2826	2′-10 1/4" X 5′-1 1/4"	MEETS EGRESS OF 5.0 SQ. FT.
C	WINDSOR	9	2816	2′-10 1/4" X 3′-5 1/4"	
D	WINDSOR	16	3224	3′-2 1/4" X 4′-9 1/4"	MEETS EGRESS OF 5.0 SQ. FT.
E	WINDSOR	5	2416	2′-6 1/4" X 3′-5 1/4"	
F P	R BUILD e r	4	BASEMENT WINDOW	PER BUILDER	
G					
H					
l					
]					
K					
L					
<u>L</u>					
	NOTES:				
		NEET EGRESS OF 5.7	SQ. FT. OF CLEAR OPN	CHEDULE	
- 		TYPE			REMARKS
0.	VINDOWS B & D A	TYPE NSUL MTL	DOORS	CHEDULE	REMARKS
0.	QUANT'Y	TYPE	DOOR S	CHEDULE SIZE	REMARKS
0.	QUANT'Y	TYPE NSUM ATCL SWING NSUL ATCL	DOOR S	CHEDULE SIZE 3'-0" X 6'-8"	REMARKS
D. 2	QUANT'Y	TYPE NSUL AT'L SWING NSUL AT'L SWING	DOOR S	SIZE 3'-0" X 6'-8" 2'-8" X 6'-8"	REMARKS
). 2	QUANTY 16 4 28	TYPE INSUL MI'L. SWING INSUL MI'L. SWING W'D SWING	DOOR S FRAME WOOD WOOD WOOD	SIZE 3'-0" X 6'-8" 2'-8" X 6'-8" 2'-6" X 6'-8"	REMARKS
0. 2	QUANT'Y 16 4 28	TYPE NSUL MI'L SWING NSUL MI'L SWING W'D SWING W'D SWING	FRAME WOOD WOOD WOOD WOOD	SIZE 3'-0" X 6'-8" 2'-8" X 6'-8" 2'-6" X 6'-8" 2'-4" X 6'-8"	REMARKS
10. 12 3 4 5	QUANT'Y 16 4 28 4	TYPE INSUL AT'L SWING INSUL AT'L SWING W'D SWING W'D SWING W'D SWING W'D SWING	FRAME WOOD WOOD WOOD WOOD	SIZE 3'-0" X 6'-8" 2'-8" X 6'-8" 2'-6" X 6'-8" 2'-4" X 6'-8" 2'-0" X 6'-8"	REMARKS
	QUANT'Y 16 4 28 4 4	TYPE INSUL MITL SWING INSUL MITL SWING W'D SWING W'D SWING W'D SWING W'D SWING W'D P'KT.	FRAME WOOD WOOD WOOD WOOD WOOD WOOD	SIZE 3'-0" X 6'-8" 2'-8" X 6'-8" 2'-6" X 6'-8" 2'-4" X 6'-8" 2'-0" X 6'-8" 2'-0" X 6'-8"	REMARKS

3′-0" X 6′-8" 9′-0" X 7′-0"

To the best of my knowledge these plans are drawn to comply with owner's and/ or builder's specifications and must be verified by a qualified structural engineer before construction begins. Any changes made on them after prints are made will be done at the owner's and / or builder's expense and responsibility. The contractor shall verify all dimensions and enclosed drawing. RESIDENTIAL DESIGN SERVICES, INC. is not liable for errors once construction has begun. While every effort has been made in the preparation of this plan to avoid mistakes, the maker can not guarantee against human error. The contractor of the job must check all dimensions and other details prior to construction and be solely responsible thereafter.

NOTES:

1) BUILDING CONTRACTOR/HOME OWNER TO REVIEW AND VERIFY ALL DIMENSIONS, SPECS, AND CONNECTIONS BEFORE CONSTRUCTION BIGINS

2) ALL JOIST, RAFTER, AND BEAM SIZES AND DESIGN MUST BE VERIFIED FOR COMPLIANCE WITH LOCAL CODES AND BUILDING CONDITIONS. PRIOR TO BEGINNING CONSTRUCTION.

3) VERIFY WINDOW SIZES WITH WINDOW MANUFACTURER FOR COMPLIANCE WITH INGRESS/ EGRESS REQUIREMENTS.

4) ATTIC VENTILATION SHALL BE DESIGNED ACCORDING TO LOCAL CODES AND CLIMATE.
5) PROVIDE PROPER FLASHING WHERE REQUIRED. 6) THE DESIGN OF ALL STAIRCASES MUST COMPLY WITH THE LATES CODES AND REQUIREMENTS 7) BATHROOM WINDOWS 60" ABOVE TUBS AND SHOWERS TO BE TEMPERED GLASS

		NEW
I/ WE HAVE REVIEWED THIS CONSTRUCTION BLUEPRINT AND UNDERSTAND TOTALL WORK TO BE PERFORMED. ANY ERRORS, OMMISSIONS, OR DISCUSSIONS NOT SPECIFICCALLY LISTED ON THE BLUEPRINT, OR WRITTEN INTO THE CUSTOM SPECIFICATIONS HAVE NOT BEEN CHARGED FOR BY THE BUILDER. AND THEREFORE BECOME EXTRAS BEYOND THE CONTRACT TO BE PAID FOR BY US.	Y, THE	
		DRAW
NAME	DATE:	RDS, II
		AUTHORIZA
NAME	DATE:	

N RESIDENCE FOR: ARCHBALD TOWNHOUSES SCALE: 1/4"=1' SECOND FLOOR PLAN -∆-4 W/ D SCHEDULE

